
SOUTHWEST TRANSIT EV CHARGING STATION ADDITION

ELECTRICAL SHEET LIST						
SHEET NUMBER	SHEET NAME					
E0.0	ELECTRICAL TITLE SHEET					
E1.0	ELECTRICAL BUILDING OVERALL PLAN					
E2.0	ELECTRICAL POWER PLAN					
E3.0	ELECTRICAL ONE-LINE DIAGRAM					
E4.0	ELECTRICAL DETAILS					
SHEET TOTAL: 5						

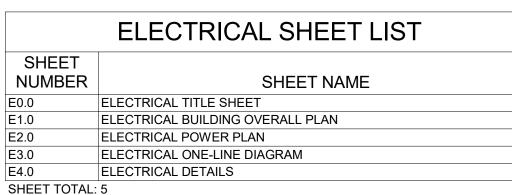

W end st	W 62nd St hton's Garage &
Southwest Transit or Leonard L. Simish	
Indian Chile f Rd	
Indian Chief Rd Pawis Decegy Day	Dayto

ELECTRICAL ABBREVIATIONS

MOMENTARY CONTACT OR MECHANICAL CONTRACTOR

MCB MAIN CIRCUIT BREAKER MCC MOTOR CONTROL CENTER

A, AMP AMPERES

ABOVE

ABOVE GRADE AUDIBLE ALARM

ABOVE COUNTER

AC	ABOVE COUNTER	MCC	MOTOR CONTROL CENTER		THE PARTY OF THE P			A SELECTION OF THE PARTY OF THE	200	27 //	Tit				
ACH	ABOVE COUNTER HEIGHT	MH	MAN HOLE							4	4				
ADD	ADDENDUM	MLO	MAIN LUG ONLY						Dawa	Paramy (Namara)					
AFC	AVAILABLE FAULT CURRENT	MMFO	MULTI MODE FIBER OPTIC		一种,一种,一种,一种,一种,一种,一种,一种,一种,一种,一种,一种,一种,一				Paws	roddiy neivosus	A STATE OF THE STA				
AFCI	ARC FAULT CIRCUIT INTERRUPTER	MRS	MOTOR RATED SWITCH		一种种种种种种种种种种种种种种种种种种种种种种种种种种种种种种种种种种种种				100	A STATE OF THE STA					
AFF	ABOVE FINISHED FLOOR	MSB	MAIN SWITCHBOARD												
AHU	AIR HANDLING UNIT	MT	EMPTY												
AL	ALUMINUM	MTR	MOTOR												
ANT	ANTENNA	N	NEUTRAL												
ATS	AUTOMATIC TRANSFER SWITCH	NC	NORMALLY CLOSED												
AV	AUDIO VISUAL	NEC	NATIONAL ELECTRICAL CODE		ELECTRICAL SYMBOLS LEGEND										
AWG	AMERICAN WIRE GUAGE	NIC	NOT IN CONTRACT		T										
BAS	BUILDING AUTOMATION SYSTEM	NO	NORMALLY OPEN	SYMBOL	DESIGNATIONS	MTG S	SYMBOL	DESIGNATIONS	MTG HT	SYMBOL	DESIGNATIONS	MTG HT	SYMBOL	DESIGNATIONS	MTG
BFC	BELOW FINISHED CEILING	NTS	NOT TO SCALE						П			ПІ			HT
BPS	BOLTED PRESSURE SWITCH	ос	ON CENTER		SYMBOL SCHEDULE NOTES			POWER			ONE LINE AND RISER			ONE LINE AND RISER	
С	CONDUIT OR CONTROLLED RECEPT	РВ	PULL BOX OR PUSHBUTTON						VEDIEV						
CAB	CABINET	PE	PNEUMATIC ELECTRIC		SYMBOLS COMPRISE A STANDARD LIST, NOT ALL SYMBOL	LS MAY		BRANCH CIRCUIT PANEL	VERIFY	\\\\\\\\\\\\\\\\\\\\\\\\\\\\\\\\\\\\\\	UTILITY SERVICE: EQUIPMENT ID		(XX)	FEEDER DESCRIPTION: SEE ELECTRICAL ONE LINE SHEET FOR SC	CHEDULE
СВ	CIRCUIT BREAKER	PF	POWER FACTOR		R ON THESE DRAWINGS.	\vdash	EQUIPMENT CABINET VERIFY		-	VOLTAGE, PHASE, 3 OR 4 WIRE					
CCTV	CLOSED CIRCUIT TV	PH	PHASE		ING HEIGHTS INDICATED ARE STANDARD. DIMENSIONAL NIFED AT DEVICES SHALL OVERRIDE THESE STANDARDS. M		<u> </u>	TRANSFORMER	VERIFY	ID	ENGINE GENERATOR:			MOTOR OVERLOAD PROTECTION DEVICE	
CKT	CIRCUIT	PNL	PANEL		S ARE TO THE CENTER OF THE DEVICE, UNLESS NOTED C		\mathcal{L}	MOTOR OR MOTOR CONNECTION	VERIFY	KW/KVA V, Ø, W	EQUIPMENT ID KW/KVA RATING OF GENERATOR		- ~>		
CLG	CEILING	PRI	PRIMARY		ING HEIGHTS INDICATED ARE FOR STUD WALL CONSTRUC		\boxtimes	MOTOR CONTROLLER, STARTER OR VFD	VERIFY	PF PF	VOLTAGE, PHASE, 3 OR 4 WIRE, POWER FACTOR				
COMM	COMMUNICATIONS	PT	POTENTIAL TRANSFORMER		BLOCK OR BRICK CONSTRUCTION IS USED, ADJUST MOUN 'S TO ALIGN DEVICE PLATES WITH RUNNING JOINT.	1TING		COMBINATION STARTER & DISCONNECT SWITCH	VERIFY	XX	600 VOLT MOLDED CASE CIRCUIT BREAKER:		U ID	POTENTIAL TRANSFORMER: TR = TURNS RATIO	
СТ	CURRENT TRANSFORMER	R	RACEWAY				42	FUSED DISCONNECT SWITCH	VERIFY	AF/AT	AF = AMP FRAME, AT = AMP TRIP XX = OPTIONS TO BE PROVIDED, MAY BE BLANK		TR:XX	IR - IURNS RATIO	
CTRL	CONTROL	RECEPT	RECEPTACLE	D. REFER	TO SPECIFICATIONS FOR FURTHER INFORMATION.		<u> </u>	DISCONNECT SWITCH	VERIFY	XX	600 VOLT INSULATED CASE CIRCUIT BREAKER:		'	CURRENT TRANSFORMER:	
CU	COPPER	REFG	REFRIGERATOR				\$ ^{MR}	MOTOR RATED TOGGLE	VERIFY		AF = AMP FRAME, AT = AMP TRIP		→ ID TR:XX	TR = TURNS RATIO	
DAS	DISTRIBUTED ANTENNA SYSTEM	RTU	ROOF TOP UNIT		GENERAL		\$ ^{MMS}	MANUAL MOTOR STARTER SWITCH WITH THERMAL	VERIFY	AF/AT	XX = OPTIONS TO BE PROVIDED, MAY BE BLANK		J IR:XX		
DED	DEDICATED	SEC	SECONDARY	[]	HEAVY DASHED LINE WEIGHT INDICATES			OVERLOAD		XX	DISCONNECT SWITCH:			GROUND CONNECTION	
DN	DOWN	SGB	SERVICE GROUND BAR		EXISTING ITEM TO BE REMOVED.		⊕ ⊕	DUPLEX RECEPTACLE - WALL/CEILING MOUNT	18"		AS = AMP SWITCH XX = OPTIONS TO BE PROVIDED, MAY BE BLANK		<u> </u>		
EC	ELECTRICAL CONTRACTOR	SMFO	SINGLE MODE FIBER OPTIC		LIGHT SOLID LINE WEIGHT INDICATES EXISTING		+ +	EMERGENCY DUPLEX RECEPTACLE - WALL/CEILING MOUNT	18"	AS XX			=		
EGB	ELECTRICAL GROUND BAR	SPKR	SPEAKER		ITEM TO REMAIN.		Ø ₩	SPLIT DUPLEX RECEPTACLE - WALL/CEILING MOUNT	18"		FUSE: AF = AMP FUSE		+	BATTERY	
ELEC	ELECTRIC OR ELECTRICAL	STP	SHIELDED TWISTED PAIR		HEAVY SOLID LINE WEIGHT INDICATES NEW		~ ~		18"	AF	XX = OPTIONS TO BE PROVIDED, MAY BE BLANK				
EM	EMERGENCY	SUB	SUBSTATION		ITEM OR NEW LOCATION.		* *	EMERGENCY SPLIT DUPLEX RECEPTACLE - WALL/CEILING MOUNT	10	XX	FUSED DISCONNECT SWITCH:			CONTACTOR - NORMALLY OPEN	
EMT	ELECTRICAL METALLIC TUBING	sw	SWITCH	R	REMOVE EXISTING ITEM		Θ	SIMPLEX RECEPTACLE - WALL/CEILING MOUNT	18"		AS = AMP SWITCH, AF = AMP FUSE XX = OPTIONS TO BE PROVIDED, MAY BE BLANK		NO ————————————————————————————————————		
ENCL	ENCLOSURE	SWBD	SWITCHBOARD	RL	REMOVE EXISTING ITEM AND RELOCATE AS INDICATED				18"	AS/AF			11		
EP	ELECTRIC PNEUMATIC	TEL	TELEPHONE	X	EXISTING ITEM TO REMAIN		+ +	EMERGENCY SIMPLEX RECEPTACLE - WALL/CEILING MOUNT	10	ID KVA	TRANSFORMER: EQUIPMENT ID		NC	CONTACTOR - NORMALLY CLOSED	
EPO	EMERGENCY POWER OFF	TELCOM	TELECOMMUNICATIONS	NL	NEW LOCATION FOR RELOCATED ITEM		₩ ₩	QUADPLEX RECEPTACLE - WALL/CEILING MOUNT	18"	KVA V	KVA RATING OF TRANSFORMER PRIMARY VOLTAGE		 		
EWC	ELECTRIC WATER COOLER	TGB	TELECOMMUNICATIONS GROUND BAR		NOTEO O TAGO			EMERGENCY QUADPLEX RECEPTACLE - WALL/CEILING	18"	- <u>-</u>	SECONDARY VOLTAGE			METER:	
F	FUSE OR FUSED	TMGB	TELECOMMUNICATIONS MAIN GROUND BAR		NOTES & TAGS		+ +	MOUNT WILL SELECT THE TOTAL THE TOTA	10	ار بہلی ا	TRANSFORMER WITH SPECIAL CORE:		(M)(A)(V)	M = WATTHOUR METER, A = AMMETER, V =	VOLT METER
FA	FIRE ALARM	TR	TAMPER RESISTANT	XX	FOUNDMENT IDENTIFICATION TAG. OFF FOUNDMENT CO	CHEDITIES	#	GFI RECEPTACLE, DUPLEX/QUADPLEX - WALL MOUNT	18"	ID KVA	EQUIPMENT ID KVA RATING OF TRANSFORMER				
FAAP	FIRE ALARM ANNUNCIATOR PANEL	TSTAT	THERMOSTAT	##	EQUIPMENT IDENTIFICATION TAG - SEE EQUIPMENT SC		# #	GFI RECEPTACLE, DUPLEX/QUADPLEX - CEILING MOUNT	Γ	ļ 'Ž'	PRIMARY VOLTAGE SECONDARY VOLTAGE			LINEWORK:	
FACP	FIRE ALARM CONTROL PANEL	TYP	TYPICAL	XXX-X	FEEDER SIZE TAG - SEE POWER RISER SCHEDULE	-	c ⊕ c	GFI RECEPTACLE, DUPLEX/QUADPLEX - CONTROLLED -		<u> </u>	PANELBOARD:			- EQUIPMENT ENCLOSURE LINE	
FB	FLOOR BOX	UC	UNDER COUNTER					CEILING MOUNT		ID ID	EQUIPMENT ID				
FO	FIBER OPTIC	UF	UNDER FLOOR	(#)	KEYNOTE		c ⇔ c ⇔	DUPLEX RECEPTACLE - CONTROLLED - WALL/CEILING	18"	V,	VOLTAGE, PHASE, 3 OR 4 WIRE, AMP RATING MCB OR MLO			SWITCHGEAR BUS LINE	
FSD	FIRE-SMOKE DAMPER	UG	UNDER GROUND		RACEWAYS	L		MOUNT		A MCB	SPACES AVAILABLE CALCULATED FAULT CURRENT			BUSWAY	
FV	FILM VIEWER	UH	UNIT HEATER				<u> </u>	GFI DEAD FRONT DEVICE, NORMAL/EMERGENCY - WALL MOUNT	18"	SPACES KAIC				- NEW WORK	
G, GND	GROUND	UNO	UNLESS NOTED OTHERWISE	/ \	CONDUIT CONCEALED IN CEILING OR WALLS				18"					EXISTING WORK	
GC	GENERAL CONTRACTOR	USB	UNIVERSAL SERIAL BUS	/ \	CONDUIT CONCEALED IN THE FLOOR OR BELOW		•	SPECIAL PURPOSE RECEPTACLE - WALL/CEILING MOUNT	10	ID	TRANSFER SWITCH: EQUIPMENT ID			- DEMO WORK	
GFEP	GROUND FAULT EQUIPMENT PROTECTION	UTP	UNSHIELDED TWISTED PAIR	/ \\ UG - \	CONDUIT EXPOSED ON THE CEILING OR WALLS				4.0"	$\frac{1}{2} \begin{vmatrix} \phi & \phi & \phi, w \end{vmatrix}$	VOLTAGE, PHASE, 3 OR 4 WIRE, AMP RATING				
GFI, GFCI	GROUND FAULT CIRCUIT INTERRUPTER	V	VOLT OR VOLTAGE	#\	CONDUIT BURIED UNDERGROUND (# = DEPTH)		0 0	EMERGENCY SPECIAL PURPOSE RECEPTACLE - WALL/CEILING MOUNT	18"	A XX	OPEN/CLOSED/DELAYED CALCULATED FAULT CURRENT			- FUTURE WORK	
НН	HAND HOLE	VA	VOLT-AMP	•	CONDUIT WITH BEND DOWN		●●	FLOOR BOX - DEVICES AS INDICATED							
НОА	HAND OFF AUTO	VAC	VOLTS ALTERNATING CURRENT	*	CONDUIT WITH BEND UP			POWER POLE - DEVICES AS INDICATED	VERIFY						
IG	ISOLATED GROUND	VDC	VOLTS DIRECT CURRENT	,	CONDUIT WITH BUSHED END			GROUND REFERENCE BUS - AS NOTED - WALL/CEILING		ID.	MOTOR: EQUIPMENT ID				
JBOX	JUNCTION BOX	W	WATT, WIRE OR WALL PHONE	/ *	CONDUIT WITH BREAK OR CONTINUATION		G-G	MOUNT		HP	HORSEPOWER, PHASE				
KV	KILOVOLT	WAP	WIRELESS ACCESS POINT	11	CIRCUIT HOME RUN - L1 INDICATES PANEL						MULTIFUNCTION RELAY:				
KVA	KILOVOLT-AMP	WP	WEATHERPROOF	1,3,5	- NUMBER					$\left\ \left(M \right) \left(M \right) \left(M \right) \right\ _{M}$	NUMBERS INDICATE ANSI DEVICE NUMBERS				
KW	KILOWATT	Х	EXISTING	O O	JUNCTION BOX - WALL/CEILING MOUNT										
KWH	KILOWATT-HOUR	XFMR	TRANSFORMER												
	•	•	· · · · · · · · · · · · · · · · · · ·		•				,	•					

14405 WEST 62ND STREET EDEN PRAIRIE, MN 55346 DUNHAM Dunham Associates, Inc. 50 South Sixth Street / Suite 1100 Minneapolis, Minnesota 55402-1540 PHONE 612.465.7550 FAX 612.465.7551 WEB dunhameng.com mechanical + electrical consulting engineering CONSULTANTS CERTIFICATION I HEREBY CERTIFY THAT THIS PLAN, SPECIFICATION, OR REPORT WAS PREPARED BY ME OR UNDER MY DIRECT
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SOUTHWEST TRANSIT

REVISIONS No. Date Description
08/30/2024 CD ISSUE

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ELECTRICAL TITLE

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EXISTING 750 KW UTILITY TRANSFORMER

1" = 20'-0"

SOUTHWEST TRANSIT



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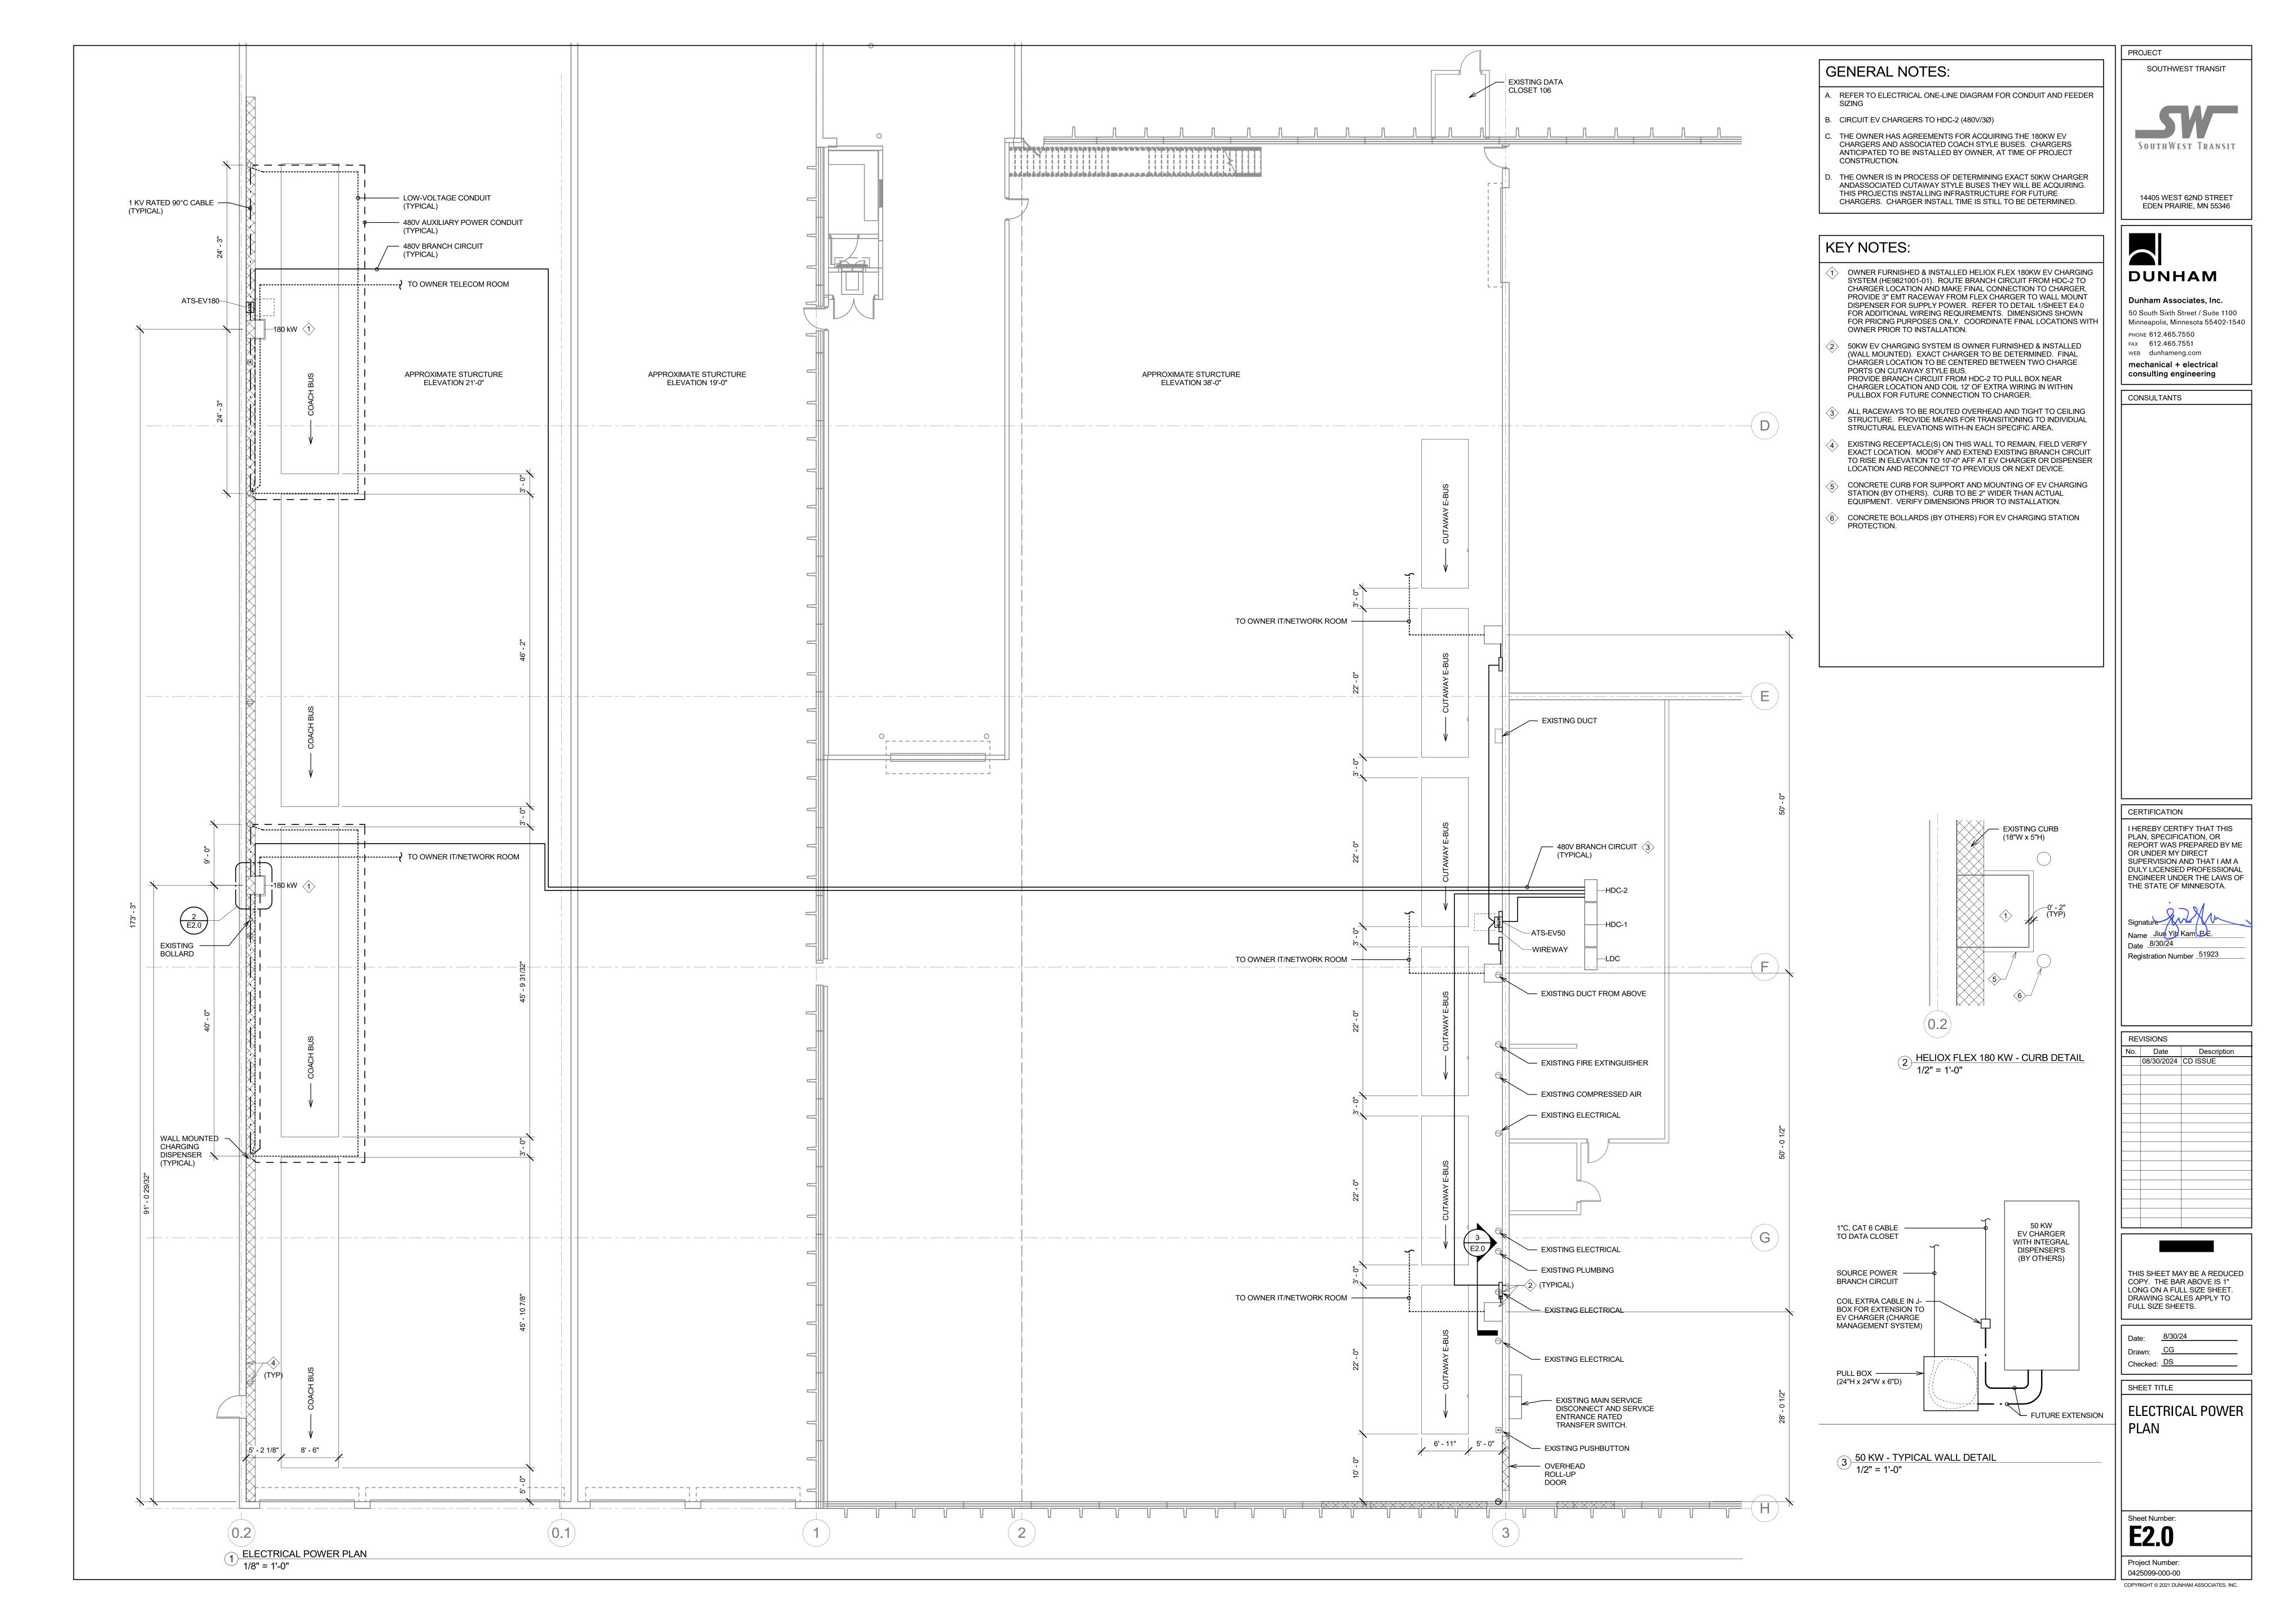
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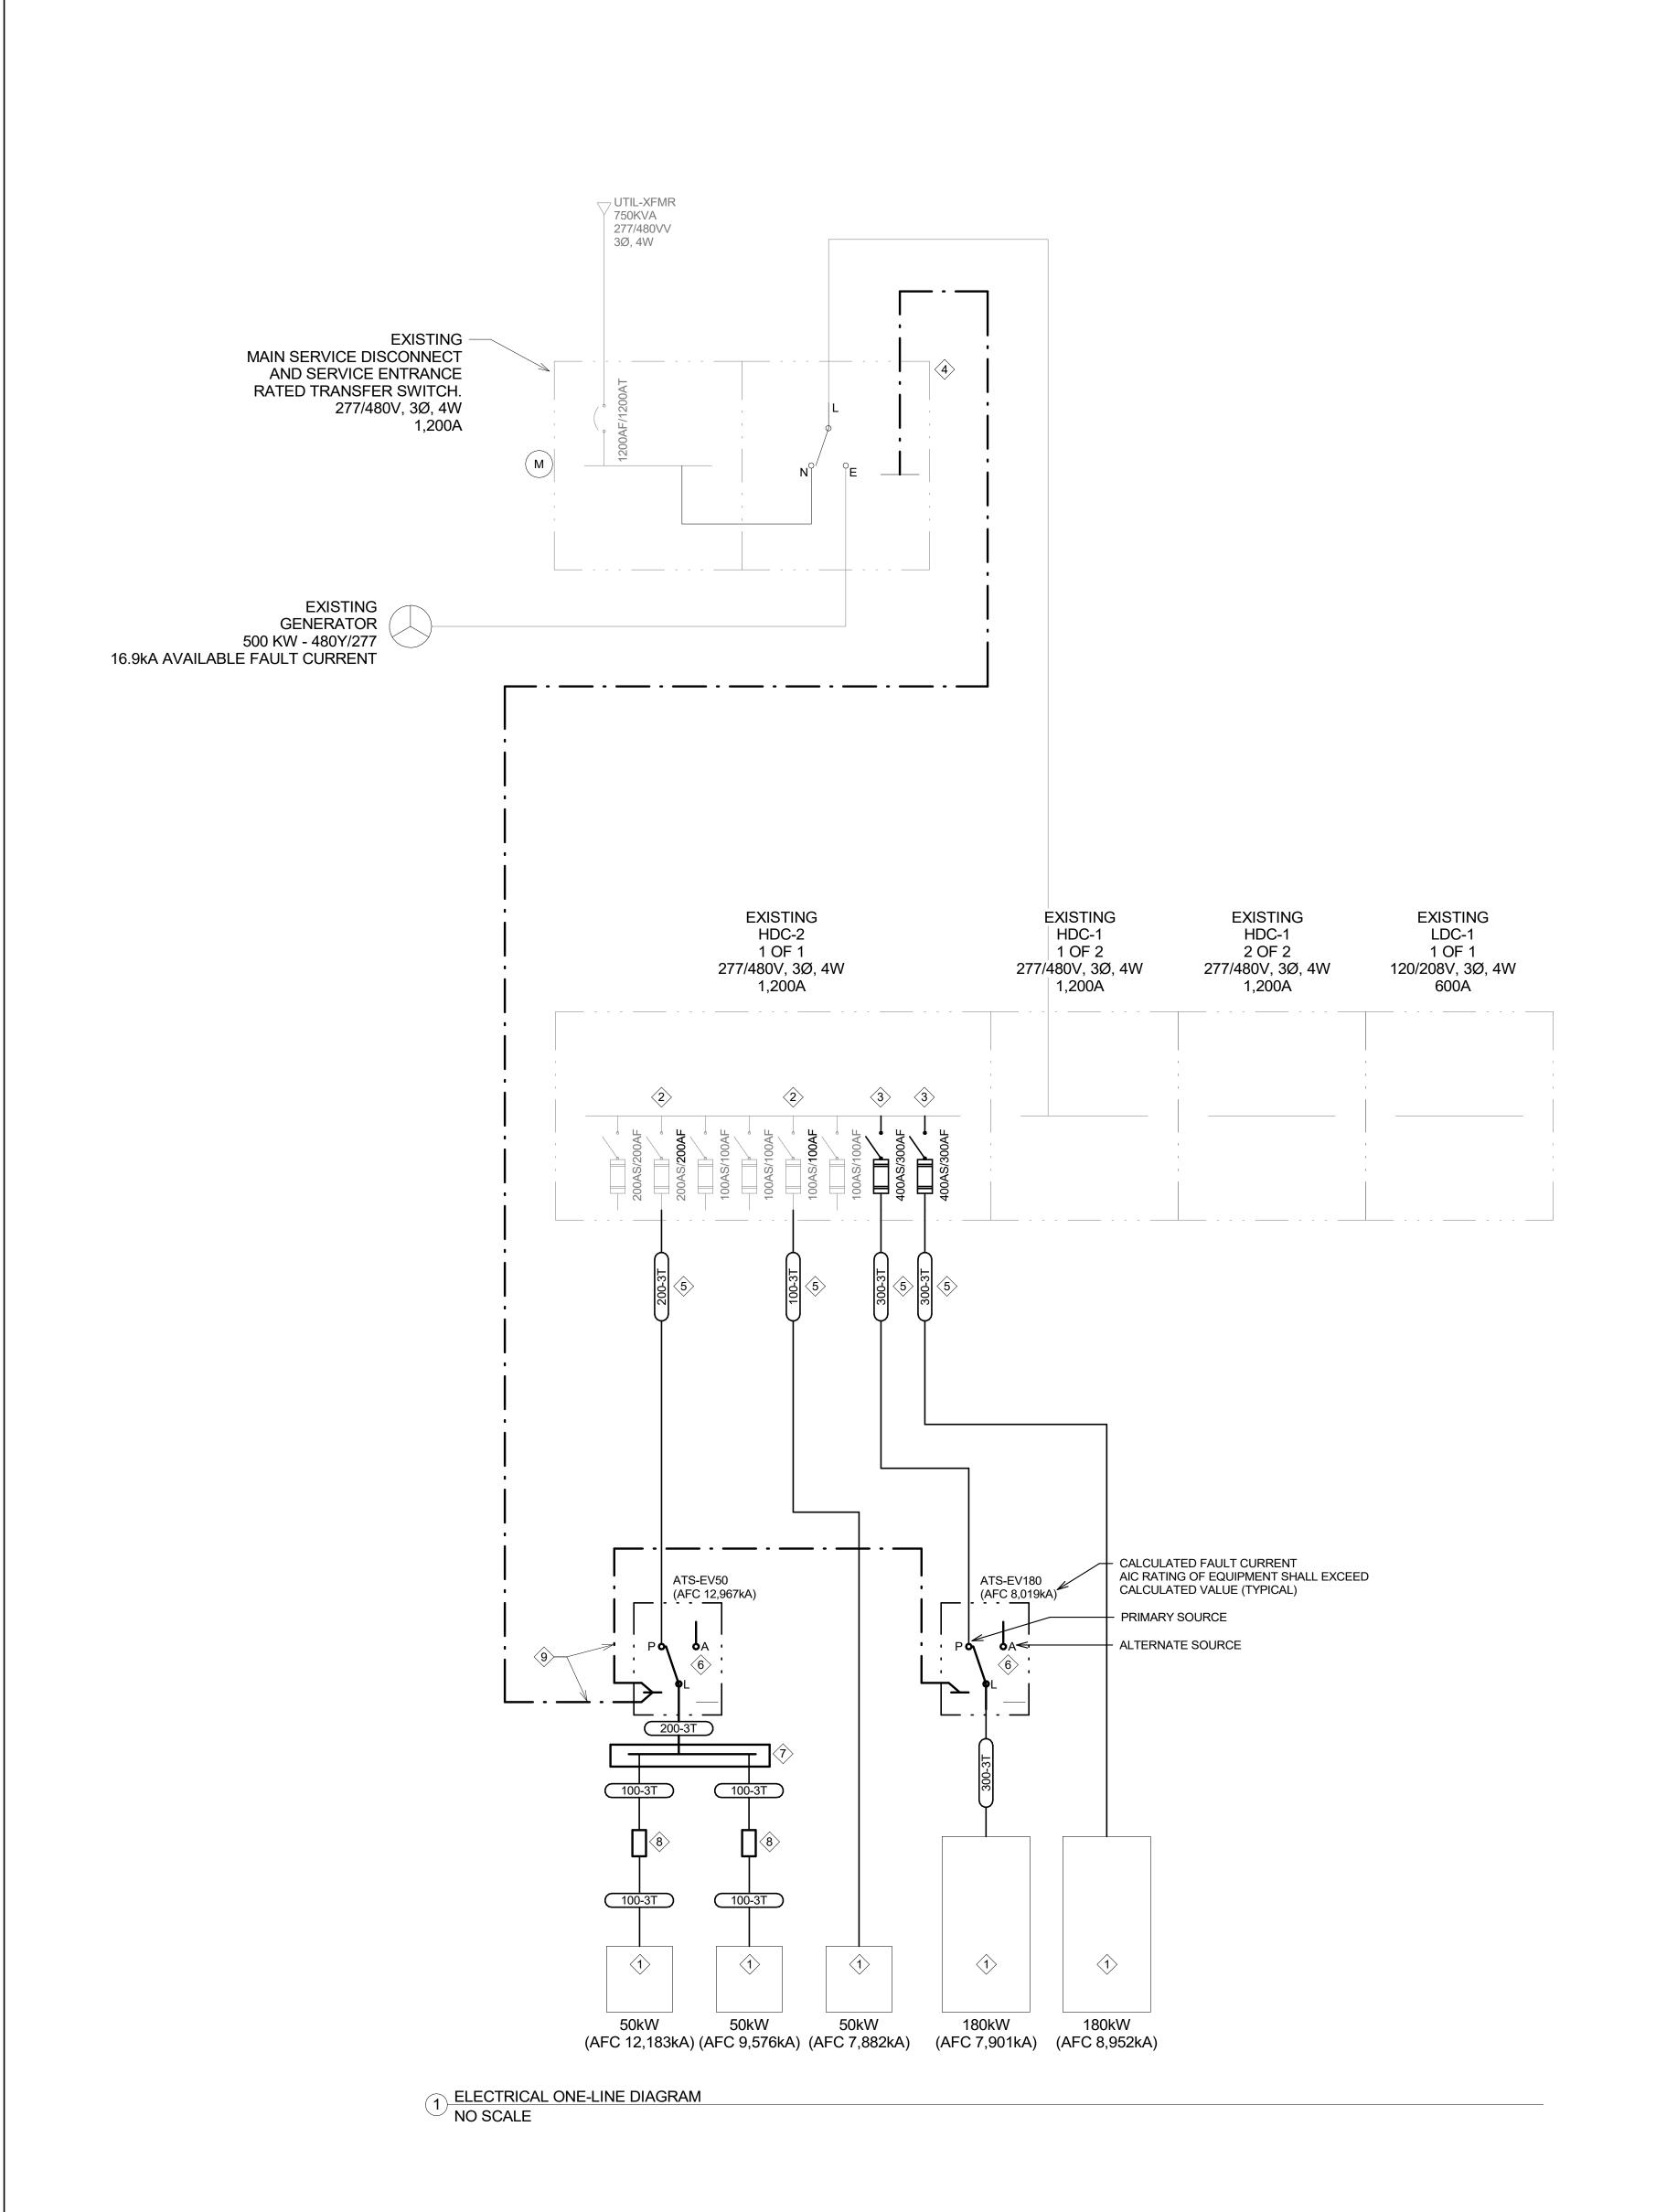
ELECTRICAL BUILDING OVERALL

PLAN

E1.0

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TRANSFER SWITCH SCHEDULE ATS NAME | VOLTAGE | SIZE | SWITCH TYPE | TRANSFER POLES | TRANSITION | MOUNTING OPTIONS ATS-EV50 480 V 300 A AUTOMATIC OPEN WALL ATS-EV180 480 V 300 A AUTOMATIC OPEN WALL FRONT LSR

TRANSFER SWITCH OPTIONS: BI - BYPASS ISOLATION

DO - DRAW OUT ECC - ELEVATOR CONTROL CONTACTS ECM - ETHERNET COMMUNICATIONS MODULE ESR - ELEVATOR/ESCALATOR PRE-TRANSFER ON - OVERSIZED NEUTRAL PM - POWER MANAGER RA - REMOTE ANNUNCIATOR

SCM - SERIAL COMMUNICATION MODULE SMDR - SEQUENTIAL MOTOR DISCONNECT RELAY

GENERAL NOTES . SEE RISER DIAGRAM FOR CALCULATED AVAILABLE FAULT CURRENT. TRANSFER SWITCH SHALL HAVE HIGHER SHORT-CIRCUIT CURRENT RATING THAN CALCULATED VALUE SHOWN ON RISER DIAGRAM.

IPM - IN-PHASE MONITOR

LSR - LOAD SHED RELAY

MDR - MOTOR DISCONNECT RELAY

ELECTRICAL NOTES:

. PROVIDE NEMA 3R ENCLOSURE WITH INTERNAL STRIP HEATER.

FEEDER	R SCHEDULE		
<u> </u>			
FEEDER	FEEDER DESCRIPTION	CONDUIT	NOTES
100-3T	1-1/4"C, 3#3 + #8 G	EMT	1
200-3T	2"C, 3#3/0 + #6 G	EMT	
	3"C, 3#350KCMIL + #4 G	EMT	

SINGLE PHASE -3 THREE PHASE

SE SERVICE ENTRANCE SECONDARY (LV TRANSFORMER) SIZED FOR VOLTAGE DROP

PVC UNDERGROUND

ALUMINUM

ADDED NEUTRAL THREE WIRE ONLY, NO NEUTRAL

GENERAL NOTES:

A. NOMENCLATURE DEFAULTS WITH A SINGLE NEUTRAL AND A GROUND.

I. FEEDER SIZE INCREASED DUE TO UNKNOWN CHARGER MANUFACTURE AND EXACT CHARGER TO BE FURNISHED BY OWNER.

MEZZ XFMR

2 EXISTING HDC-2

KEY NOTES:

- OWNER FURNISHED AND INSTALLED EV CHARGER. CONTRACTOR TO MAKE FINAL CONNECTIONS.
- 2 PROVIDE NEW FUSES IN EXISTING SWITCH.
- 3 PROVIDE 400AS/300AF SWITCH IN EXISTING SWITCHBOARD.
- 4 EXISTING TRANSFER SWITCH IS ZENITH/STATES ELECTRIC. INCLUDE COSTS FOR ANY REQUIRED PROGRAMMING/EQUIPMENT MODIFICATIONS TO SEND TRANSFER SIGNAL TO ATS-EV50 AND ATS-EV180
- 5 ALL FEEDERS SHALL BE ROUTED OVERHEAD, TIGHT TO CEILING STRUCTURE TO MAINTAIN MAXIMUM CLEARANCES.
- 6 ALTERNATE BUS TO BE OPEN/NOT CONNECTED FOR LOAD SHEDDING DURING GENERATOR OPERATION.
- 7 PROVIDE 8"x8"x48" WIREWAY.

8 PROVIDE 100A FUSED SWITCH AND SIZE FUSES PER EV CHARGER MANUFACTURES RECOMMENDATION.

PROVIDE 3/4"C, 2#12 CABLING TO RECEIVE SIGNAL FROM SERVICE ENTRANCE ATS TO ATS-EV50 AND ATS-EV180.

GENERATOR OPERATION SEQUENCE

UPON GENERATOR STARTING AND SERVICE ENTRANCE TRANSFER SWITCH SWITCHING TO ALTERNATE SOURCE. TRANSFER SWITCH SHALL SEND SIGNAL TO ATS-EV50 AND ATS-EV180 THAT THE BUILDING IS OPERATING ON ALTERNATE POWER SOURCE.

- UPON RECEIVING SIGNAL THAT BUILDING IS OPERATING ON ALTERNATE POWER SOURCE, ATS-EV50 AND ATS-EV180 SHALL TRANSFER TO







ELECTRICAL LOAD CALCULATION

SWT BLDG MAX DEMAND PER OWNERS LOAD STUDY:	221.00KW
DEMAND FACTOR PER NEC 220.87:	1.25%
DESIGN MAXIMUM DEMAND:	276.25KW
ADDED EV CHARGER LOAD:	510KW
TOTAL BUILDING DESIGN LOAD:	786.25KV
BUILDING SERVICE SIZE:	1200 <i>A</i>
TOTAL BUILDING DESIGN:	946 <i>A</i>
BUILDING SERVICE SPARE CAPACITY:	254

CONSULTANTS

- ALTERNATE SOURCE (LOAD SHED MODE).
- AFTER UTILITY POWER IS RESTORED AND SERVICE ENTRANCE ATS HAS TRANSFERED BACK TO PRIMARY POWER SOURCE, ALTERNATE SOURCE SIGNAL IS LOST, AND ATS-EV50 AND ATS-EV180 SHALL TRANSFER BACK AUTOMATICALLY TO PRIMARY SOURCE.

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EDEN PRAIRIE, MN 55346

DUNHAM

Dunham Associates, Inc.

PHONE 612.465.7550 FAX 612.465.7551

WEB dunhameng.com mechanical + electrical consulting engineering

50 South Sixth Street / Suite 1100

Minneapolis, Minnesota 55402-1540

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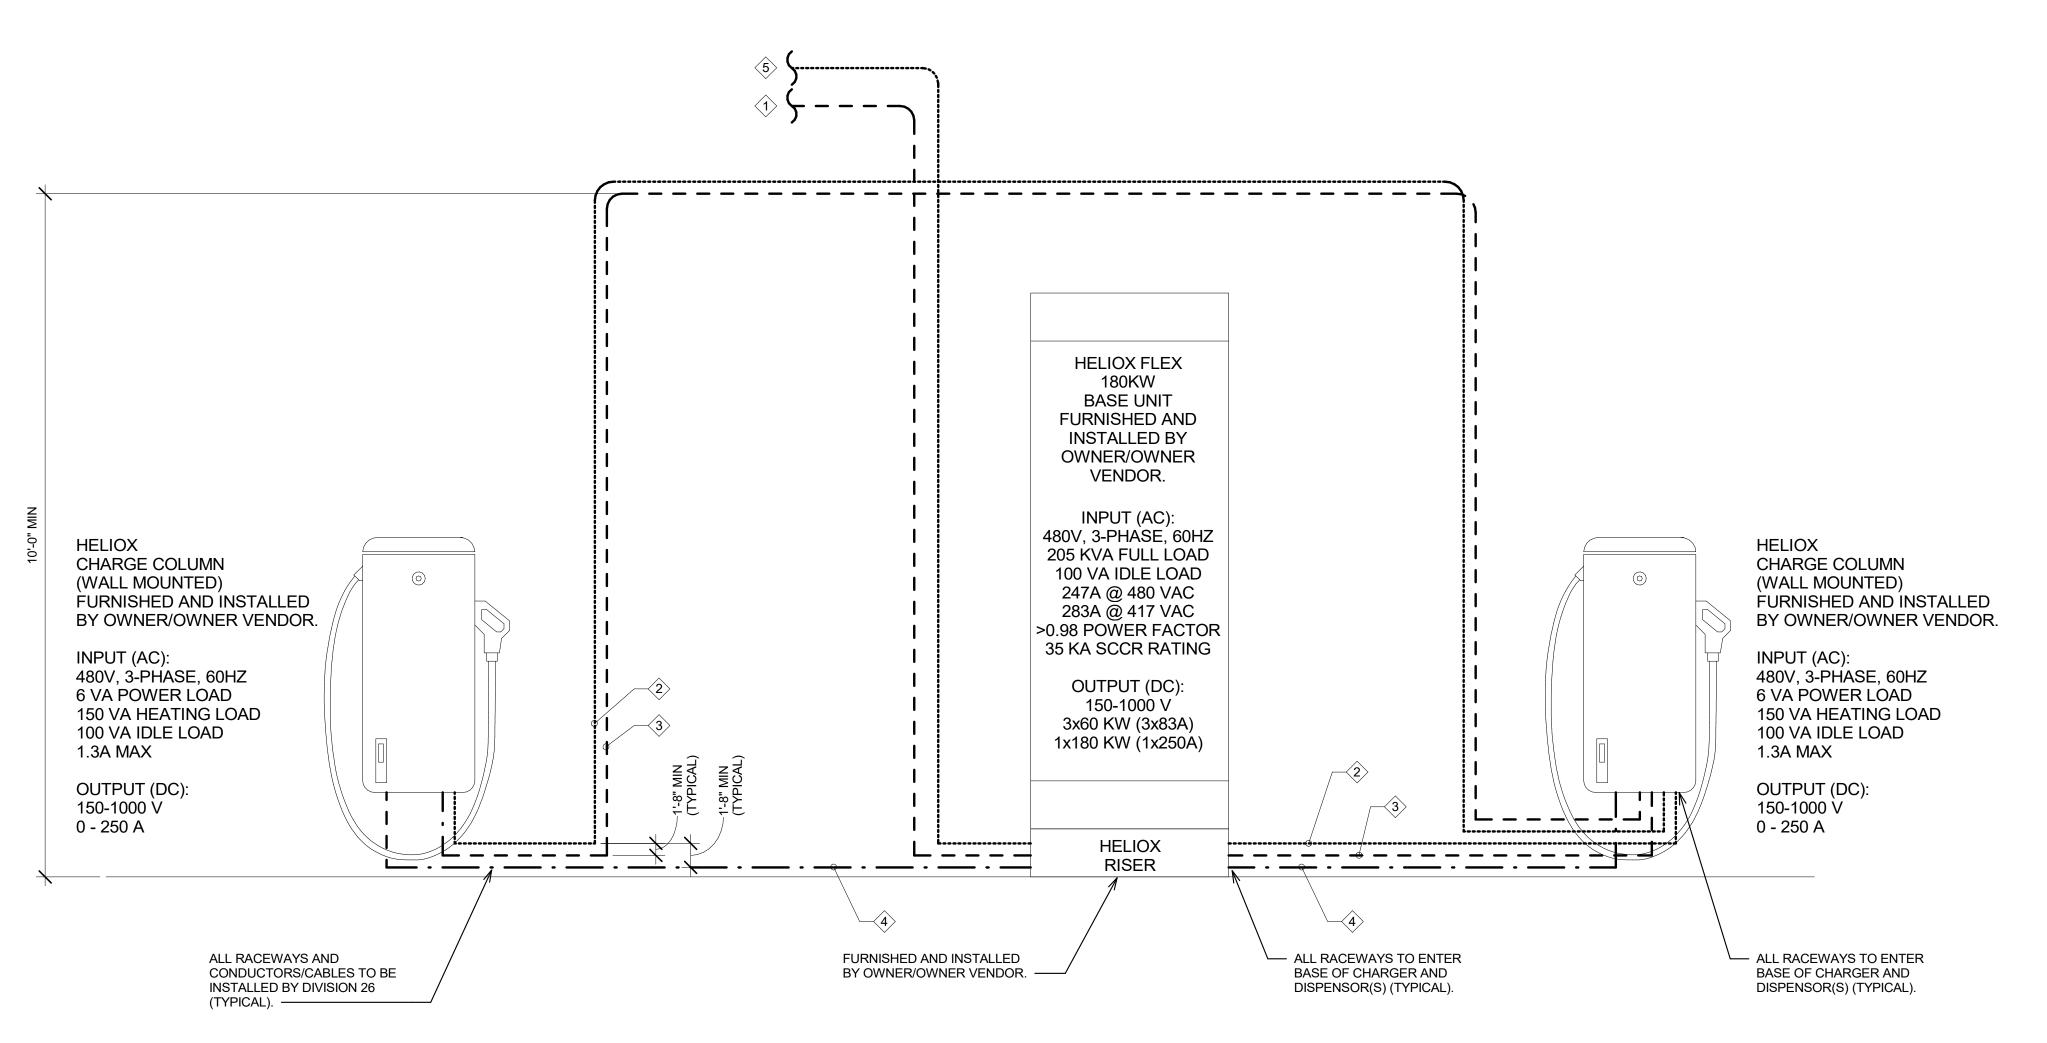
SHEET TITLE

ELECTRICAL ONE-LINE DIAGRAM

E3.0

Project Number: 0425099-000-00

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	FEEDER SCHEDULE								
TAG	FROM	ТО	CONDUIT/CABLE SPECIFICATIONS	NOTES					
< 1 >	CUSTOMER FEEDER BREAKER	180KW FLEX BASE STATION	SEE ONE-LINE DIAGRAM						
(2)	180KW FLEX BASE STATION OR CHARGE COLUMN	CHARGE COLUMN	 1" CONDUIT 480VAC, 3-PHASE + GROUND 600V RATED 90°C CABLE #12 AWG CU THWN 						
3>	180KW FLEX BASE STATION OR CHARGE COLUMN	CHARGE COLUMN	 1 1/2" CONDUIT DOOR INTERLOCK: 2#18 AWG E-STOP: 2#18 AWG CAN: #22 AWG 2-WIRE TWISTED SHIELDED PAIR WITH 120 OHM CHARACTERISTIC IMPEDANCE EITHERNET: CAT 6 S/FTP CABLE 	RIGID METAL CONDUIT OR SEPARATE FROM AC AND DC POWER CONDUITS BY 20" MINIMUM. TOTAL DISTANCE LIMITED TO 250 METERS FROM BASE STATION TO LAST CHARGE COLUMN WITH SINGLE RUNS LIMITED TO 100 METERS.					
4>	180KW FLEX BASE STATION	CHARGE COLUMN	 3" CONDUIT 1 KV RATED 90°C CABLE (2 SETS) 3/0 						
\(5 \)	180KW FLEX BASE STATION	DATA CLOSET 106 (CUSTOMER CHARGE MANAGEMENT SYSTEM)	 1" CONDUIT CAT 6 SHIELDED CABLE 	CONNECTION TO CUSTOMER CHARGE MANAGEMENT SYSTEM.					

- 1. ALL COPPER CONDUCTORS SHALL BE USED.
- 2. ALL CONDUCTORS UL LISTED AND RATED FOR 90°C AND WET LOCATIONS. FLEXIBLE CABLE RECOMMENDED FOR AC AND DC CABLE.
- 3. COMMUNCATION AND CONTROL CABLE DAISY CHAIN TERMINATIONS SHALL FOLLOW ORDER OF DC POWER TERMINCATION (DC OUTPUT 1 FIRST, DC OUTPUT 2 SECOND, DC OUTPUT 3 THIRD IN DAISY CHAIN).

1 HE100 - HELIOX FLEX 180KW - BASE UNIT NO SCALE

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SHEET TITLE

ELECTRICAL DETAILS

E4.0

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